




**THE PORT AUTHORITY
OF NY & NJ**

Peter K. Sweeney
ENGINEERING PROGRAM MANAGER
WORLD TRADE CENTER
CHIEF ARCHITECT

NOTES:

1. THE CONTRACTOR SHALL REMOVE EXISTING CEILING TILES, SUSPENSION SYSTEM, LIGHT FIXTURE AND SPRINKLER IN THE TRANSFORMER ROOM.
2. FOR TRANSFORMER ROOM CEILING LIGHT FIXTURE LOCATION AND DETAIL SEE ELECTRICAL DWG. E-94
3. FOR EXISTING ACOUSTIC CEILING TILES SEE NOTE #10 ON DWG. A-1

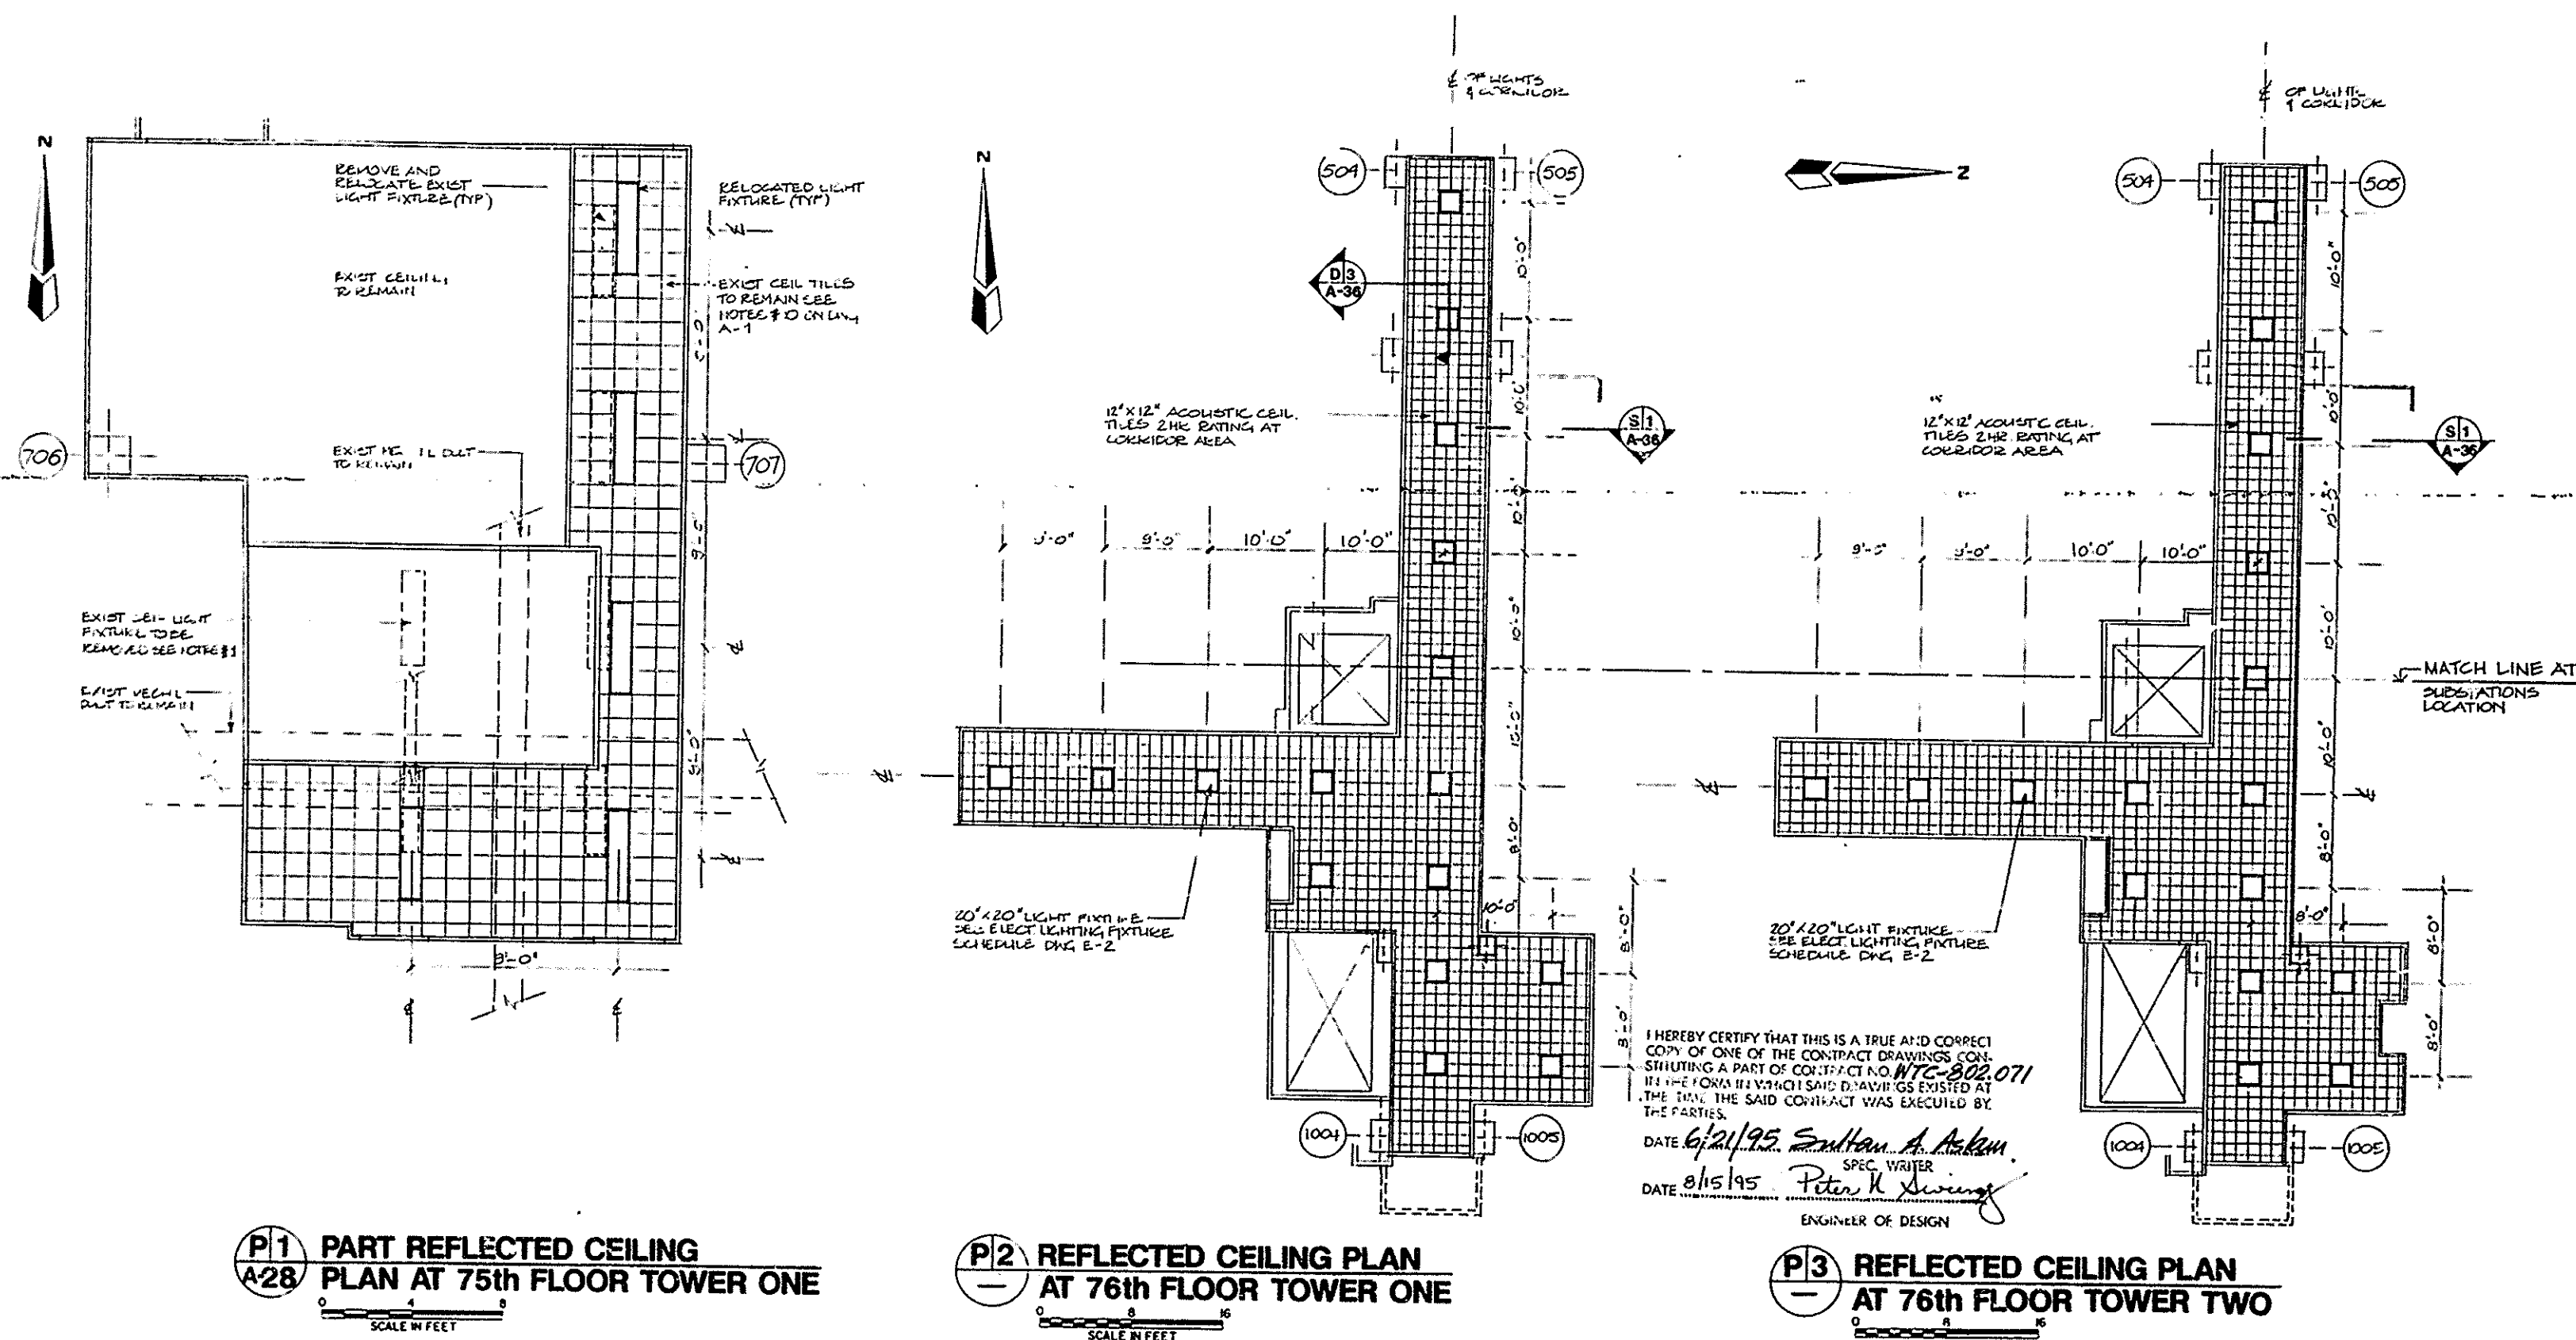

No. Date Revision Approved

Engineering Department
Design Division

The World Trade Center
Electrical/HVAC Upgrade Program

Title
**TOWERS ONE AND TWO
LOW VOLTAGE SUBSTATIONS
CONSTRUCTION AND
INSTALLATION**
**ARCHITECTURAL
SUBSTATION - SS 75 AND 76
TOWERS ONE AND TWO
REFLECTED CEILING PLANS**

This drawing subject to conditions in contract. All inventions, ideas, designs and methods herein are reserved to Port Authority and may not be used without its written consent.

AT.SOLANA A.T.S. L.V.GALAN
Designed by Drawn by Seal Leader
Principal Architect
Date 5/1/95 Scale AS NOTED

Contract Number Drawing Number
WTC-802.071 A-29